
KEYED NOTES

1 LIGHT HAZARD NEW ADDITION AREA.

2 FIELD VERIFY LOCATION AND SIZE OF EXISTING SPRINKLER MAIN LINE. CONNECT NEW SPRINKLER LINE TO EXISTING SPRINKLER MAIN. VERIFY MAIN IS OF SUFFICIENT SIZE FOR NEW ADDITION.

3 COORDINATE CEILING REMOVAL AND REPLACEMENT IN EXISTING AREAS WITH GENERAL CONTRACTOR FOR ROUTING NEW FIRE SPRINKLER LINE TO NEW ADDITION. FIELD VERIFY ROUTING ON SITE.

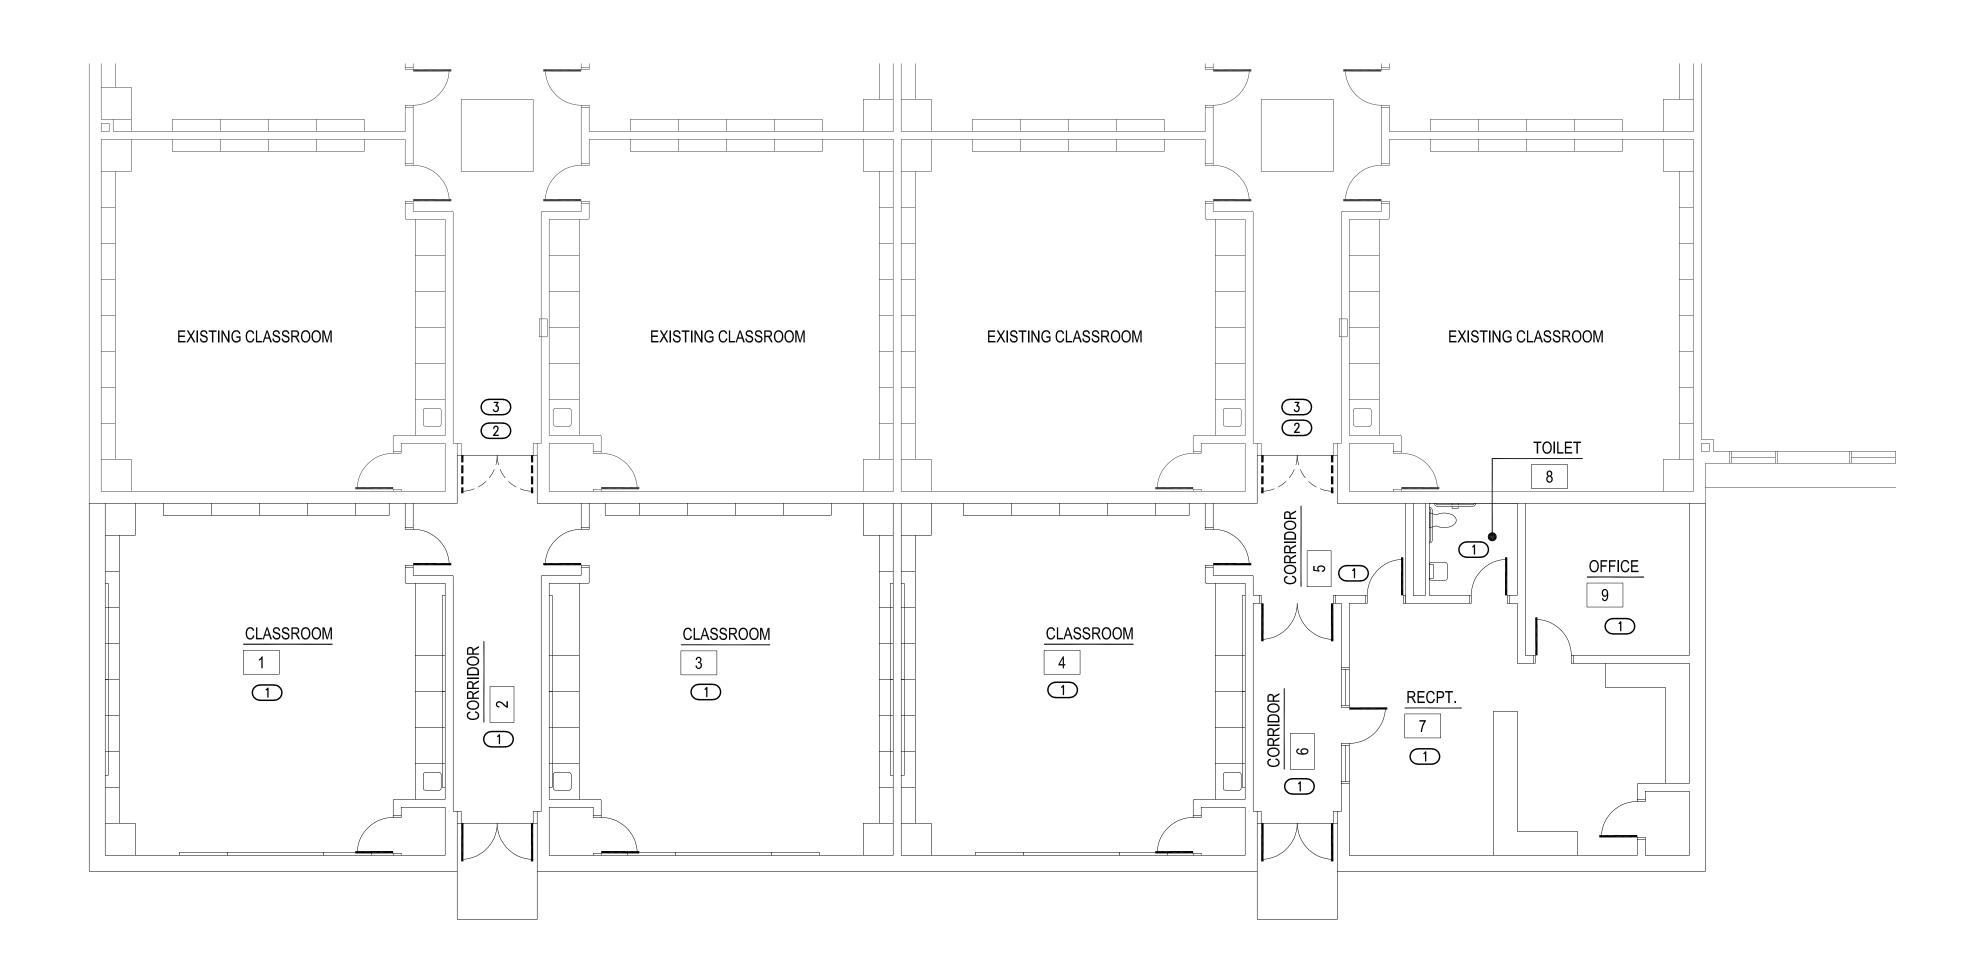

 $\begin{array}{ccc}
& & \text{FIRE PROTECTION PLAN} \\
\hline
1/8" = 1'-0" & & & \\
\end{array}$



FIRE PROTECTION ABBREVIATIONS ADDENDUM GALLOŇ ADDL ADDITIONAL GENERAL CONTRACTOR GPM GALLONS PER MINUTE ADJUSTABLE AFF ABOVE FINISH FLOOR MC MECHANICAL CONTRACTOR ABOVE FINISH GRADE MECH MECHANICAL MINIMUM ALTERNATE MIN NTS BELOW GRADE NOT TO SCALE CI COL PLUMBING CONTRACTOR CAST IRON PLBG PLUMBING COLUMN QTY SCH CW COLD WATER QUANTITY SCHEDULE ELECTRICAL CONTRACTOR SPEC SPECIFICATIONS FD FDC FLR FLOOR DRAIN SS TEMP TYP W/ STAINLESS STEEL FIRE DEPARTMENT CONNECTION TEMPERATURE FLOOR TYPICAL FIRE PROTECTION WITH

FIRE PROTECTION SYMBOL LEGEND

- ↓↓	SHUTOFF VALVE
	CHECK VALVE
├\	DOUBLE CHECK VALVE
E	END CAP
\checkmark	FIRE DEPARTMENT CONNECTION(FDC)
$\widehat{\Box}$	BELL

FIRE PROTECTION PIPING LINETYPES LINETYPE DESCRIPTION

<u>LINETYPE</u>	DESCRIPTION
	NEW – ABOVE GRADE
	NEW — BELOW GRADE

FIRE PROTECTION GENERAL NOTES

CONTRACTOR SHALL PROVIDE DESIGN FOR SPRINKLER SYSTEMS FOR NEW BUILDING ADDITION.

COORDINATE INSTALLATION OF SPRINKLER PIPING AND ALL COMPONENTS WITH OTHER TRADES, OWNER, AND GENERAL CONTRACTOR.

FIRE PROTECTION SYSTEM TO COMPLY WITH NFPA 13, INSURANCE CARRIER

4. CUTTING OF STRUCTURAL AND/OR ARCHITECTURAL MEMBERS TO BE DONE ONLY WITH THE WRITTEN APPROVAL OF THE ARCHITECT AND STRUCTURAL ENGINEER.

. PROVIDE MINIMUM 10 PSI SAFETY FACTOR.

AND ALL APPLICABLE STATE AND LOCAL CODES.

6. WORKING DRAWINGS INDICATING SPRINKLER HEAD LOCATIONS AND EXPOSED AND CONCEALED PIPING ROUTING SHALL BE PROVIDED TO THE ARCHITECT/ENGINEER PRIOR TO INSTALLATION FOR APPROVAL.

7. FIRE PROTECTION CONTRACTOR IS RESPONSIBLE FOR ORGANIZING A COORDINATION MEETING WITH OTHER TRADES AND OWNER PRIOR TO INSTALLATION.

. SYSTEM PIPING LOCATION: WET SYSTEM PIPING SHALL BE INSTALLED AT HIGHEST ELEVATION POSSIBLE. PIPING SHALL BE INSTALLED ABOVE ALL MECHANICAL EQUIPMENT, DUCTWORK, AND ALL PLUMBING SYSTEM PIPING. PROVIDE ADEQUATE CLEARANCE TO MECHANICAL UNITS. FIRE PROTECTION CONTRACTOR SHALL COORDINATE FIRE PROTECTION PIPING PRIOR TO INSTALLATION.

PROPERLY TORQUE MECHANICAL TEES TO MANUFACTURER'S RECOMMENDATIONS.

RECOMMENDATIONS

O. FIRE PROTECTION PLANS ARE FOR REFERENCE ONLY. OCCUPANCIES AND AREAS OF PROTECTION NOTED ON THE PLANS SHALL BE CONFIRMED WITH NFPA 13 AND AUTHORITIES HAVING JURISDICTION. THIS CONTRACTOR SHALL COMPLY WITH ANY CODE REQUIREMENTS AS REQUIRED.

1. REFER TO ARCHITECTURAL FIRE CODE PLAN FOR ADDITIONAL INFORMATION.

FIRE PROTECTION SHEET INDEX

-100 FIRE PROTECTION PLAN, NOTES & SYMBOLS

AGP the Abla Griffin Partnership L.L.C.

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KFC ENGINEERING

STRUCTURAL

SALAS O'BRIEN

MECHANICAL / ELECTRICAL



KPP
drawn by

DG
checked by

APRIL 2022
date

MOORE PUBLIC SCHOOLS BOARD OF EDUCATION MOORE, OKLAHOMA



NEW CLASSROOM
ADDITION SOUTH LAKE
ELEMENTARY SCHOOL

sheet no:

F100



2600 Van Buren St., Suite 2635 Norman, Oklahoma 73072 P: 405.364.9926 | CA#:7058 Expiration Date: 6/30/2023

Salas O'Brien Project No.: 2022-01376-00

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